

Town of Brookline Massachusetts

333 Washington Street Brookline, MA 02445-6899 (617) 730-2130 Fax (617) 730-2442

> Steve Heikin, Chair Robert Cook, Clerk James Carr Linda K. Hamlin Blair Hines Mathew Oudens Mark J. Zarrillo

To: Brookline Board of Appeals

From: Brookline Planning Board

Date: February 22, 2018

Subject: Convert existing three-family dwelling into a four-family dwelling through

renovation of the basement

Location: 10 Fuller Street

Atlas Sheet: 15 Case #: 2017-0047 Block: 77 Zoning: M-1.5

Lot: 21 Lot Area (s.f.): 3,864

Board of Appeals Hearing: March 8, 2018 at 7:00 pm

BACKGROUND

<u>February 8, 2018</u>: The Planning Board heard this case and raised concerns about the large increase in FAR necessitating a variance. The Board discussed options for the applicant to offer a benefit to the Town such as an affordable unit. They also requested that additional trash space and storage be added, the roof deck be shrunk and trash barrels be removed from the front yard.

SITE AND NEIGHBORHOOD

10 Fuller Street is a three-family row house located between Winchester Street and Centre Street. The structure was built in 1900 and consists of three units, one on each floor, and an unfinished basement. The building currently has no parking. The neighborhood consists mostly of similar style row houses and multi-unit buildings. The abutting buildings contain six and nine units. Across the street is a townhouse complex managed by Senior Hebrew Life. The property is located close to the Coolidge Corner business district.

APPLICANT'S PROPOSAL

The applicant, Aura on Fuller, LLC, proposes to convert the existing basement into an additional dwelling unit, for a total of four units. Following the initial Planning Board meeting, the applicant has chosen to reduce the size of the proposed new unit. The new unit will contain 1,490 square feet with two bedrooms, and one and a half baths. The prior proposal was 2,352 square feet with three bedrooms, a den and two and a half baths. The remaining floor space at the garden level space will now be a larger common shared trash/recycling room and storage area. The basement/street level is currently about 70% above grade and the proposed conversion will require minimal exterior modification, although new windows will be installed. The applicant will provide one off-site parking space for this unit in Coolidge Corner through a long-term lease agreement. A roof deck will also be added for the exclusive use of Unit 3 which has been reduced in size with 450 square feet added as a landscape roof garden.

FINDINGS

Section 5.05 – Conversions

In the case of a conversion ... in an F or M district, the structure shall conform to all dimensional requirements specified in 5.01. However, the Board of Appeals may waive by special permit any of said dimensional requirements, provided that no previously existing nonconformity to such requirements is increased and provided that all other requirements are met.

Section 5.09.2.d - Design Review

Exterior alterations associated with multiple dwellings with four or more units on the premises require a **special permit** subject to design review standards listed under **Section 5.09.4 (a-m)**. The most relevant design review sections are described below:

c. Relation of Buildings to the Form of the Streetscape and Neighborhood – The existing basement is approximately 70% above grade with front windows that face Fuller Street. There will be minimal exterior modifications that will not impact the relation of the building to the street. There are similar basement conditions along this entire block.

e. <u>Circulation</u>

The proposal will not add any additional vehicle traffic to the site or neighborhood. One off-site parking space will be provided.

Section 5.20 - Floor Area Ratio

M-1.5	Allowed	Existing	Proposed	Relief
FAR (%)	1.5 (100%)	1.8 (120%)	2.2 (146%)	Variance*
Gross Floor Area	5,796 sf	7,263 sf	8,753 sf	Variance

^{*} Relief under Deadrick does not apply to dwellings greater than two units

Section 5.43 – Exceptions to Yard and Setback Requirements

Section 5.50 – Front Yard Requirements

<u>Section 5.90 – Minimum Usable Open Space</u>

<u>Section 5.91 – Minimum Landscaped Open Space</u>

M-1.5	Required	Existing	Proposed	Relief
Front-Yard Setback	18.5 feet	15 feet	15 feet	Special Permit*
Minimum Landscaped Open Space	10%	none	5%	Special Permit**
Minimum Usable Open Space	15%	none	3%	Special Permit**

^{*} Under **Section 5.43**, the Board of Appeals may waive yard and/or setback requirements by special permit if counterbalancing amenity is provided.

<u>Section 6.02, Paragraph 1 – Table of Off Street Parking Requirements</u>

Parking	Required	Existing	Proposed	Relief
Off-Street Parking Spaces	8	0	1	Variance

<u>Section 6.01.2.a</u> – General Regulations Applying to Required Off-Street Parking Facilities
In F, M, L, or G Districts, when a structure is converted for one or more additional dwelling units and the conversion results in an increased parking requirement, parking requirements for the entire structure shall be provided in accordance with the requirements of §6.02 and §6.05.
However, the Board of Appeals by special permit under Article IX may waive not more than one-half the number of parking spaces required under §6.02 and §6.05.

PLANNING STAFF ANALYSIS

The Planning staff recognizes that the creation of a basement unit will have minimal impact on the design of the building or streetscape. The unfinished basement space already exists and there will be only minor exterior modifications. The staff appreciates that the applicant incorporated feedback from the Planning Board's first meeting to add additional common trash and storage space, reducing the deck and adding a green roof and removing trash barrels from the front yard.

^{**} Special Permit available under **Section 5.05** as cited above

The staff remains concerned about setting a precedent allowing additional units in multi-family dwellings that are already at or above the allowable FAR. Because there are no FAR bonuses available for M districts and because Deadrick only applies to one- and two-family dwellings, the applicant requires a variance to add additional habitable space as well as for an exception to the parking requirements. If the increased density is allowed, the impact should be mitigated by having the unit be an affordable unit, thus increasing the affordable housing supply in Brookline, which is a stated goal cited in the Zoning By-Law. (See Brookline Zoning ByLaw, Art. I, Sec. 1.00 - Purpose and Interpretation.)

PLANNING BOARD RECOMMEDATION

The Planning Board supported the changes made in these revised plans. The Board commended the architect for incorporating the changes that the Board had suggested at the previous meeting including the additional trash and common storage, bike storage, removal of trash barrels from the front yard and large green roof area. The Board decided that it will not require that the new unit be a below market rate affordable unit, but recognized that by reducing the size of the unit substantially, the unit will be more affordable in comparison to larger market rate units in Coolidge Corner.

Therefore, should the Board of Appeals find that the statutory requirements for a variance are met, the Planning Board recommends approval of the site plan by Stephen Desroche, dated 9/13/2017 and floor plans and elevations by EMBARC Studios dated 2/13/2018, subject to the following conditions:

- Prior to the issuance of a building permit, the Applicant shall submit a final site plan, floor plans, and elevations, subject to review and approval by the Assistant Director for Regulatory Planning.
- 2. Prior to the issuance of a building permit, the applicant shall submit a final landscaping plan including all counterbalancing amenities, subject to review and Approval by the Assistant Director for Regulatory Planning.
- 3. Prior to the issuance of a building permit, the applicant shall submit to the Building Commissioner for review and approval for conformance to the Board of Appeals decision: 1) a final site plan, stamped and signed by a registered engineer or land surveyor, 2) final floor plans and elevations, stamped and signed by a registered architect, and 3) evidence that the Board of Appeals decision has been recorded at the registry of Deeds.

knm





February 13, 2018

RE:

Changes to proposed design per Planning Board meeting 02.08.18

Project:

10 Fuller Street, Brookline MA

Planning Board Commission:

The attached plans show the following revisions:

- Garden level unit reduced from a 2,352 SF unit to 1,342 SF (plus 148 SF for egress, total 1,490 SF which is an 862 SF reduction.
- Added 830 SF of Common Building Area for dedicated Trash and Recycling, and Bike and Storage room
 with two means of egress for access either to front or rear stair to Winchester Street via common passage
 way.
- Reduced roof deck from 700 SF down to 280 SF (420 SF reduction), by pulling back front railing by 20' (from 35' deep to 15' deep).
- Added 450 SF of landscape roof garden.
- Called out for landscape front yard and no trash receptacles.

Sincerely,






Dartagnan Brown | Architect | Principal | 617.780.6834

10 FULLER STREET

BROOKLINE, MA 02446 **FEBRUARY 13, 2018** ISSUED FOR CONSTRUCTION

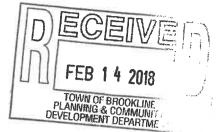

ABBREVIATIONS

ABOVE FINISHED FLOOR ACOUSTICAL CELLING THE **APPROXIMATE** ARCH. ARCHITECTURAL BLDG. BUILDING

CEILING HEIGHT CENTERLINE

CAB.
C.H.
CLR.
CL
COL
CONT.
CMU
C.J. COLUMN CONTINUOUS CONCRETE MASONRY U CONTROL JOINT

DIMENSION ELEVATION

FD. F.O.C. F.O.F. F.O.S. FLOOR DRAIN FACE OF FACE OF STUD

GFIC GROUND SALIT INTERCEPTOR CIRCUIT GYPSUM WALL BOARD

H OR HVA HEATING, VENTILATING, AND AIR CONDITIONING HOSE BIB HOLLOW METAL

MAXIMUM MECHANICAL MECHANICAL ELECTRICAL PLUMBING MISCELLANEOUS

NOT IN CONTRACT NO. N.T.S. NOT TO SCALE O.C. O.D. OUTSIDE DIAMETER PAINT GRADE PLYWOOD ROOF DRAIN REQ'D. R.O. ROUGH OPENING

STAIN GRADE SIMILAR SEE LANDSCAPE DRAWING SQ.
SPEC.
S.S.D.
SSTL.
STL.
STOR.
STRUCT
SYM. SPECIFICATION SEE STRUCTURAL DRAWINGS STAINLESS STEEL SYMMETRICAL

TONGUE AND GROOVE TUBULAR STEEL UNLESS OTHERWISE NOTED V.I.F. VERIFY IN FIELD

WITHOUT WATERPROOFING MEMBRANE

SYMBOLS

BUILDING SECTION

DRAWING

INTERIOR ELEVATION

EXTERIOR ELEVATION NORTH ARROW

WINDOW TAG

A (100)

REVISION TAG

ALL WORK SHALL BE IN COMPLIANCE WITH ALL APPLICABLE FOCALS RUILDING CODES AND PEGLILATIONS. CONTRACTOR SHALL BE DESPONSIBLE FOR DEPARTS

ALL YORK SPAIL BE IN CONTINUED WITH ALL APPLICABLE LOCALS BUILDING COLDS AND REGULATIONS. CONTRACTOR SHALL BE RESPONSIBLE FOR PERMITS APPLICABLE TO SPECIFIC TRADES OR SUBCONTRACTORS. SO AS TO COMPARE THEM TO THE CONTRACT DIRAWINGS AND WILL BE FAMILIAR WITH THE RISTING CONDITIONS OF THE BUILDING AND ADDIDACTOR FOR FOR THE SUBCINED AND ADDIDACTOR THEM SO AS TO BE MADE TO INCLUDE ALL ITEMS OF WORK INCLUDING BOTH LABOR OR MATERIALS FOR ALL NOTED, DETAILS, OR IMPLIED ITEMS REQUIRED TO ATTAIN THE COMPLETED CONDITIONS PROPOSED IN THE DRAWINGS AND SPECIFICATION.

WITH THE WORK.

DRAWTHIGS SCHEMATICALLY INDICATE NEW CONSTRUCTION. THE CONTRACTOR SHALL ANTICIPATE, BASED ON EXPERIENCE, A REASONABLE NUMBER OF ADJUSTMENTS TO BE NECESSARY TO MEET THE DESIGN OBJECTIVES AND SHOULD CONSIDER SUCH ADJUSTMENTS AS INCLUDED IN THE SCOPE OF WORK.

WHEN SPECIFIC FEATURES OF CONSTRUCTION ARE NOT FULLY SHOWN ON THE DRAWINGS OR CALLED FOR IN THE GENERAL NOTES, THEIR CONSTRUCTION SHALL BE OF THE SAME CHMARACTER AS SIMILAR CONDITIONS.

ALL DIMENSIONS ARE TO BE TAKEN FROM NUMERIC DESIGNATIONS ONLY, DIMENSIONS ARE NOT TO BE SCALED OFF OF THE DRAWINGS.

THESE NOTES ARE TO APPLY TO ALL DRAWINGS AND GOVERN UNLESS MORE SPECIFIC REQUIREMENTS ARE INDICATED THAT ARE APPLICABLE TO PARTICULAR DIMSIONS OF THE WORK. SEE SPECIFICATIONS AND GENERAL NOTES IN THE INDIVIDUAL SUBSECTIONS OF CONTRACT DOCUMENTS FOR ADDITIONAL INFORMATION.

HOME INCLUDING SPECIFICATION S

DMISIONS OF THE WORK. SEE SPECIFICATIONS AND GOLDSCAPE.

MICHAELS OF THE WORK SEES SPECIFICATION AND GOLDSCAPE.

ALL DIMENSIONS ARE TO FACE OF FINISH UNLESS OTHERWISE NOTED.

PROVIDE WEATHERSTRIPPING AT ALL DOORS LEADING FROM HEARTED TO UNHEATED AREAS. PROMDE VINIVE BEAD TYPE WEATHERSTRIPPING AT THESE DOORS AND WINDOWS. ALL SIDES OF NEW DOORS ARE TO BE WEATHERSTRIPPING INCLUDING THE THRESHOLD.

CALIK AND SEAL OPENINGS IN BUILDING EXTERIOR TO A THECKNESS OF 18° OR GREATER TO PREVENT AIR INFILTRATION.

ALL WINDOWS ARE TO BE OPERABLE FOR CLEANING UNLESS OTHERWISE NOTED.

ALL GYBSUM BOARD SHALL BE 5/8° THICK UNLESS OTHERWISE NOTED.

STRUCTURAL WOOD MEMBERS ADJACENT TO CONCRETE ARE TO BE PRESSURE TREATED DOUGLAS FIR.

DESIGN IS BASED ON THE INTERNATIONAL BUILDING CODE (IBC) 2009, THE INTERNATIONAL ENERGY CONSERVATION CODE (IBC) 2009, AND THE MASSACHUSETTS BUILDING CODE 2009 AMENDMENTS. CONSTRUCTION SHALL CONFORM WITH ALL APPLICABLE SECTIONS.

VICINITY MAP

SHEET INDEX

PROJECT DATA

TOTAL (GSF)	7,263 SF	B,753 SF
THIRD FLOOR	2,421	2,421
SECOND FLOOR	2,421	2,421
FIRST FLOOR	2,421	2,421
GARDEN LEVEL	0	1,490
FLOOR	DUSTING	PROPOSED
GSF BREAKOUT		

PLOT PLAN DEMOLITION PLANS

USEABLE OPEN SPACE

18'-6" 22'-6"

15% OF GSF

LOT AREA LOT WIDTH F.A.R. HEIGHT

OTAL (GSF)	7,263 SF	B,753 SF
HIRD FLOOR	2,421	2,421
ECOND FLOOR	2,421	2,421
IRST FLOOR	2,421	2,421
GARDEN LEVEL	0	1,490
LOOR	DUSTING	PROPOSED
OSF BREAKOUT		

1.5 (7.500 SF) 1.82 (7.263 SF) 2.19 (8.753 SF

STREET FULLER 0


ONSTRUCTION

FOR

ISSUED

EMBARC 60 K STREET, THIRD FLOOR BOSTON, MA 02127 617.766.8330

49 COOLIDGE STREET, BROOKLINE MA

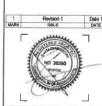

PROJECT # 17064


DRAWING TITLE **COVER**

SCALE:


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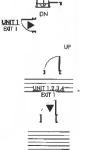
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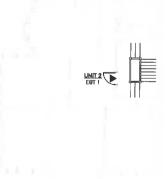
EGRESS PLANS




GARDEN LEVEL EGRESS PLAN

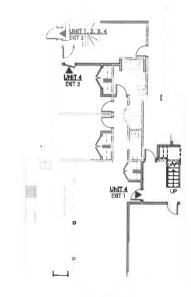



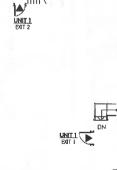

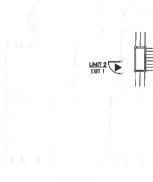



ARCHITECT EMBARC

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AURA PROPERTIES
49 COOLIDGE STREET,
BROOKLINE MA

FOR CONSTRUCTION 10 FULLER STREET BROOKLINE, MA 02446 ISSUED

ISSUED FOR CONSTRUCTION FEBRUARY 13, 2018 PROJECT #

DRAWING TITLE

AERIAL MAP

DRAWING NUMBER

A003







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OWNER
AURA PROPERTIES
49 COOLIDGE STREET,
BROOKLINE MA

10 FULLER STREET BROOKLINE, MA 02446

ISSUED FOR CONSTRUCTION

FEBRUARY 13, 2018

EXISTING PHOTOS

DRAWING NUMBER

A004

GENERAL NOTES

- WHEN SPECIFIC FEATURES OF CONSTRUCTION ARE NOT FULLY SHOWN ON THE DRAWINGS OR CALLED FOR IN THE GENERAL NOTES, THEIR CONSTRUCTION SHALL BE OF THE SAME CHARACTER AS SIMILAR CONDITIONS.
- 3. ALL INTERIOR DIMENSIONS ARE TO FACE OF FINISH UNLESS OTHERWISE NOTED
- 4. ALL GYPSUM BOARD SURFACES ARE TO BE 5/8" THICK UNLESS OTHERWISE NOTED.
- ALL GYPSUM AND PLASTER FINISHES SHOULD BE SMOOTH, CONTINUOUS, FREE OF IMPERFECTIONS. AND HAVE NO VISIBLE JOINTS.
- PROVIDE GAS, WATER SPIGOT, OUTLET, AND LIGHTING AT ROOF DECKS; FOR LOCATIONS, SEE FLOOR PLANS AND REFLECTED CEILING PLANS.
- ALL CLOSETS SHALL HAVE SHELF AND POLE OR SHELVES AS REQUIRED, UNLESS OTHERWISE NOTED.
- ALL REQUIRED LIFE SAFETY DEVICES, INCLUDING SMOKE & CARBON MONOXIDE DETECTORS, SHALL BE INSTALLED BY THE CONTRACTOR IN COMPLIANCE WITH THE 2009 INTERNATIONAL BUILDING CODE

PLAN NOTES

- ALL DIMENSIONS ARE MEASURED FROM FACE OF EXISTING BRICK TO FINISH FACE OF
- G.W.B. OR FROM FINISH FACE OF G.W.B. TO FINISH FACE OF G.W.B.
- ALL DOORS ARE 84" TALL UNLESS OTHERWISE NOTED.
- ALL LYING, DINING AND KITCHENS TO HAVE AB-509 CROWN MOLDING, 4 1/2° AB-129 CASING, AND 13,8° WOOD WITH 2 3/4° BASE CAP
- ALL BEDROOMS TO HAVE AB-402 CROWN MOLDING 3 1/2' AB-102 CASING, AND 1'x6' WOOD WITH 7/8' BASE CAP

MECHANICAL | SECURITY NOTES

- PROVIDE 5.1 AUDIO WIRING FOR LIVING ROOM AND MASTER BEDROOMS; FOR NUMBER AND LOCATION, SEE REFLECTED CEILING PLANS.
- HEATING AND AIR CONDITIONING IS TO BE PROVIDED BY HIGH VELOCITY FORCED AIR SPACE PAR HIGH VELOCITY AIR CONDITIONING SYSTEMS WITH HYDRONIC HEATING.
- 4. HOT WATER IS TO BE PROVIDED BY A HIGH EFFICIENCY NAMEN MODULATING CONDENSING COMBINATION HEATING AND HOT WATER SYSTEM OR EQUAL
- 5. HARD WIRED SECURITY SYSTEM SHALL BE PROVIDED AT EACH UNIT; CONTACTS SHALL BE PRACED AT EXTERNOR DOORS AND WINDOWS WITH ONE MOTION DETECTOR PER UNIT.


ELECTRICAL NOTES

- ELECTRICAL SERVICE POWER IS TO BE EVALUATED FOR MEETING LIGHTING DESIGN
 AND EQUIPMENT REQUIREMENTS. PROPER POWER LEVEL SHALL BE PROVIDED.
- 2. ALL NEW ELECTRICAL ITEMS ARE TO BE U.L. RATED.
- ALL ELECTRICAL PANELS ARE TO BE RECESSED INTO A WALL WITH A MINIMUM 6" STUD DIMENSION. REVIEW FINAL LOCATION WITH ARCHITECT AND OWNER.
- 4. ALL DISTRIBUTION PANELS ARE TO BE NEW.
- LIVING AREAS, DINING AREAS, AND ALL BEDROOM ARE TO RECEIVE 3-WIRE JUNCTION BOXES.
- 6 PROVIDE INTERCOM AND REMOTE ENTRY DOOR ACCESS BY HOUSING DEVICES, INC. OR APPROVED EQUAL.
- 7. PROVIDE ELECTRIC HEAT MATS BY NUHEAT OR EQUAL AT ALL BATHROOMS.
- 8. ALL CLOSET LIGHTING IS TO BE FLUORESCENT OR HIGH EFFICIENCY LIGHTING.
- 9. OUTLETS IN BATHROOMS SHALL HAVE GROUND FAULT INTERCEPTORS.
- ALL DIMENSIONS FOR THE FOLLOWING ITEMS ARE TO FINISH SURFACES UNLESS OTHERWISE NOTED:
- A MOUNT ALL OUTLETS, PHONE JACKS, AND TELEVISION CABLE JACKS VERTICALLY AT 18" TO CENTERLINE ABOVE THE FINISH FLOOR UNLESS OTHERWISE NOTED. WHERE BASE AND TRIM IS LAGRER THAN 9 1/2" TALL PROVIDE 6" CLEARANCE FROM BOTTOM OF PLATE TO TOP OF BASEBOARD.
- TRIM.

 B. MOUNT ALL SWITCHES AT 42° TO CENTERUNE ABOVE FINISH FLOOR UNLESS
- OTHERWISE NOTED.

 C. VERTICALLY ALIGN SWITCHES AND OUTLETS WHERE POSSIBLE.

FLOOR PLAN LEGEND

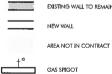



WATER SPIGOT

WATERPROOF OUTLET

TV LOCATION

STRUCTURED VIDEO LOCATION

THERMOSTAT LOCATION

ARCHITECT **EMBARC**

60 K STREET, 3RD FLOOR BOSTON, MA 02127 O: 617.766.8330 www.embarcstudio.com

OWNER

AURA PROPERTIES 49 COOLIDGE STREET, BROOKLINE MA

CONSTRUCTION 10 FULLER STREET BROOKLINE, MA 02446 FOR ISSUED

FEBRUARY 13, 2018 SCALE: 1/4" = 1'-0"

DRAWING TITLE

PROPOSED FLOOR PLANS

A101

DECK 12'-0" x **BEDROOM** BEDROOM 5'-6" 11'-9" x 7'-10" 14'-10" x 10'-0" WALK-IN CLOSET 6'-2" x 3'-7" KITCHEN W D 14'-4" x 14'-7" LAUNDRY/ BATH 8'-0" x 5'0" **BATH** 6'-2" x 9'-4" **DINING ROOM** CLOSET 12'-6" x 16'-9" 4'-2" x 9'-4" UNIT 3 COMMON STAIRS 13'-0" x 9'-4" **BEDROOM FOYER** PRIMARY ENTRY 11'-9" x 16'-6" 11'-9" x 10'-10" CLOSET CLOSET NOTE: **ALTERATIONS ARE** STUDY **BEDROOM** LIMITED TO THE 14'-7" x 11'-6" 14'-7" x 12'-1" **GARDEN LEVEL &** FRONT YARD, STAIR TO STORAGE

SECOND FLOOR - EXISTING TO REMAIN

2 THIRD FLOOR - EXISTING TO REMAIN

ARCHITECT **EMBARC**

60 K STREET, 3RD FLOOR BOSTON, MA 02127 O: 617.766.8330 www.embarcstudio.com

OWNER
AURA PROPERTIES
49 COOLIDGE STREET,
BROOKLINE MA

ISSUED FOR CONSTRUCTION 10 FULLER STREET BROOKLINE, MA 02446

ISSUED FOR CONSTRUCTION FEBRUARY 13, 2018

PROJECT # 17064 SCALE: 1/4" = 1'-0"

EXISTING PLANS TO REMAIN

DRAWING NUMBER

ARCHITECT
EMBARC

60 K STREET, 3RD FLOOR
BOSTON, MA 02127
C): 617.76.8.330
www.embarcstudio.com

OWNER
AURA PROPERTIES
49 COOLIDGE STREET,
BROOKLINE MA

ISSUED FOR CONSTRUCTION 10 FULLER STREET BROOKLINE, MA 02446


ISSUED FOR CONSTRUCTION FEBRUARY 13, 2018

DATE: <u>FEBRUARY 13, 21</u>
PROJECT # 17064
SCALE: 1/4" = 1'-0"


PROPOSED FLOOR PLANS

DRAWING NUMBER


A103 copyright: EMBARC STUDIO, LLC

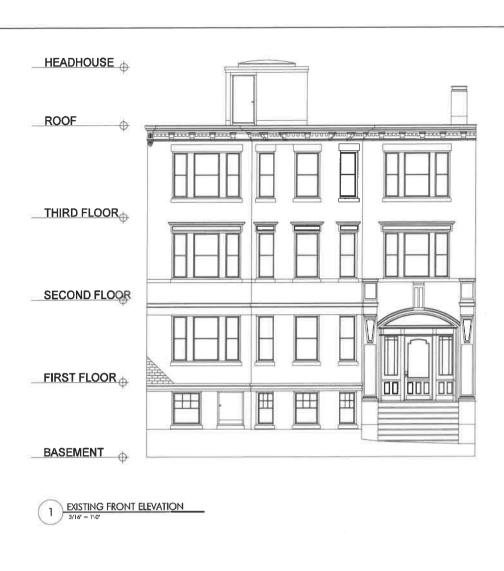



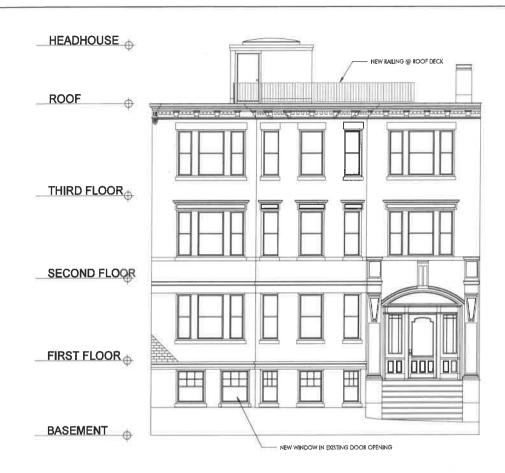

2 PROPOSED FRONT ELEVATION
3/16' = 1'.0'

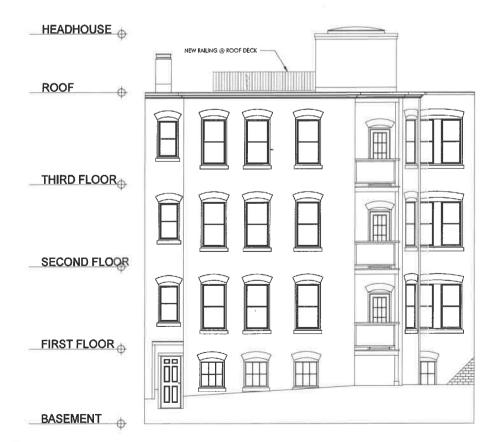

4 PROPOSED REAR ELEVATION
3/16' = 1'-0'

ARCHITECT EMBARC

60 K STREET, 3RD FLOOR BOSTON, MA 02127 O: 617.766.8330 F: 617.766.8331 www.embarcstudio.com

OWNER
AURA PROPERTIES
49 COOLIDGE STREET,
BROOKLINE MA

10 FULLER STREET
BROOKLINE, MA 02446
ISSUED FOR CONSTRUCTION

DRAWING INFORMATION

DRAWING INFORMATION

ISSUE: ISSUED FOR CONSTRUCTION

PROJECT # 17064 SCALE: 3/16' = 1'-0"


DRAWING TITLE

BUILDING ELEVATIONS

DRAWING NUMBER

A201

BASEMENT

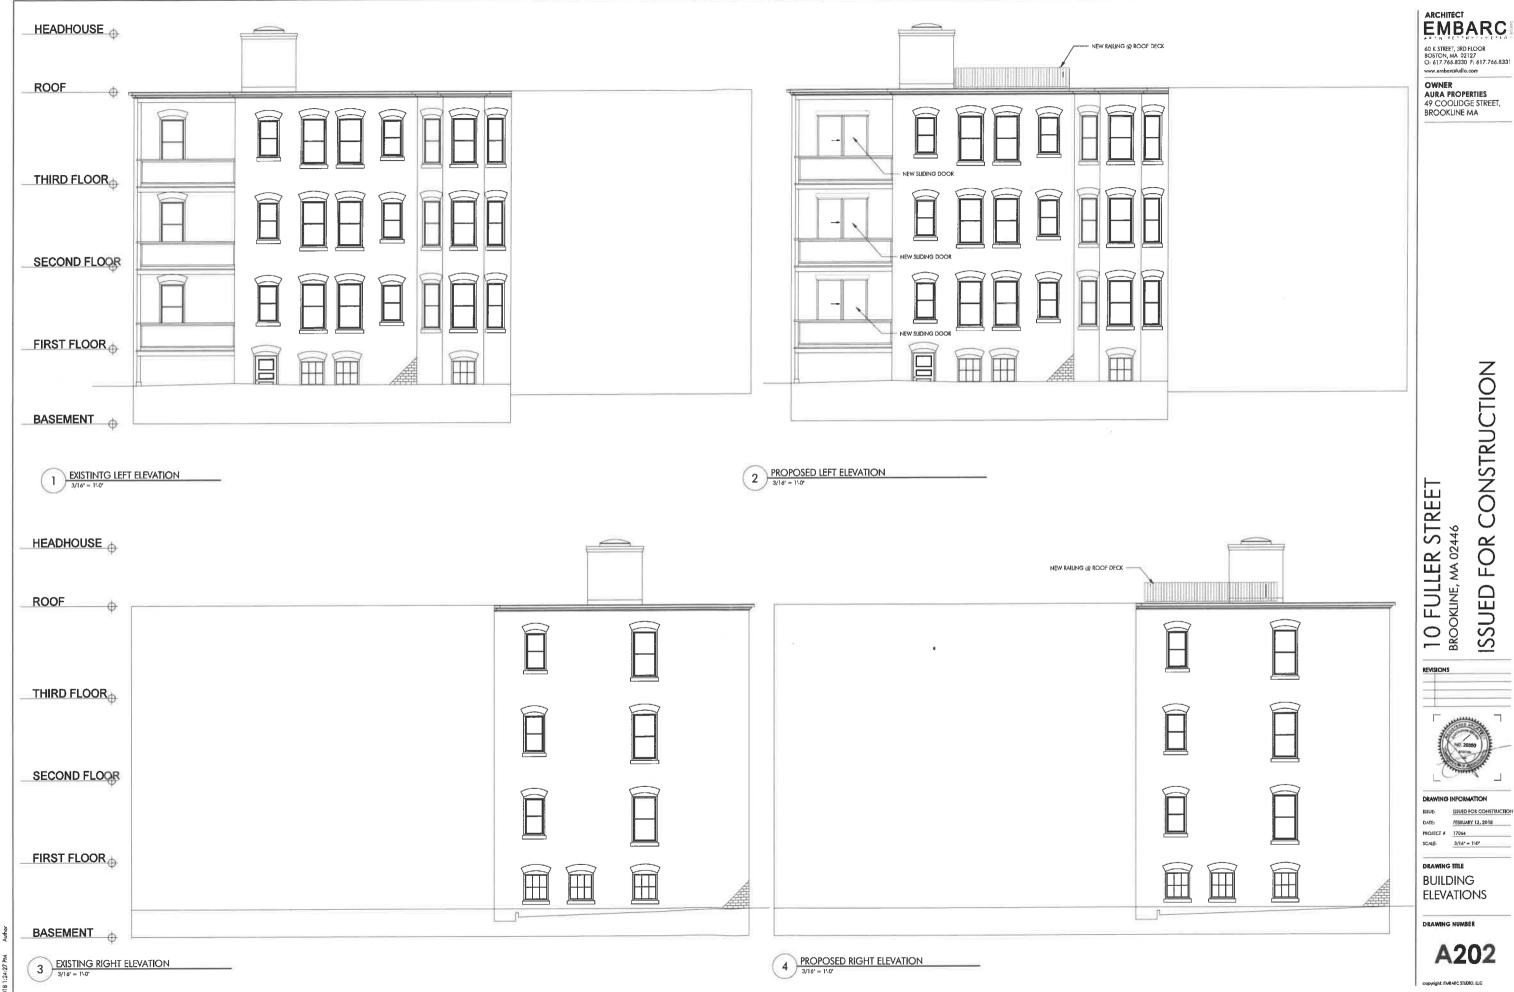

EMBARC